## COTTRUE & ENGINEERING SURVEYS

87-89 Guthrie Street, Osborne Park, Western Australia Telephone: (08) 9446 7361 Facsimile: (08) 9445 2998 Email: perth@cottage.com.au Website: www.cottage.com.au J/N:

T.Currev

DATE SCALE: DRAWN: 421257 19 Jul 17 1:200

Builder: Averna Homes CLIENT: KENWIN PROJECTS PTY LTD

LOT 213 #209 Vincent Street, West Perth JOB N°: 2162

SHEET: 01a of 06

D.Plan33158

Power Pole
Phone Pits
Water Con
Top Pillar/P
Top Wall

▲ DISCLAIMER:
Lot boundaries drawn on survey are
based on bandgabe plan only. Survey does not
include title search and as such may not show
assements or other interests not shown on plan
Title should be checked to verify all lot details
and for any easements or other interests which
may affect building on the property.


A DISCLAIMER:

A DISCLAIMER: hows visible features only and v ations of underground pipes or nal or mains services. Verificatio tion of all internal and mains ser

DISCLAIMER: DISCLAIMER: Cottage & Engineering surveys responsibility for any physical the parcel or portion of the par on this survey including any ad levels and features that have of date on this survey. All Sewer

▲ DISCLAIMER:
Due to lack of survey ma

▲ DISCLAIMER:
HIGH TENSION POWER LINES, CHECK TITLE FOR
EXCEMENTS AND WESTERN POWER FOR SET-BACKS.

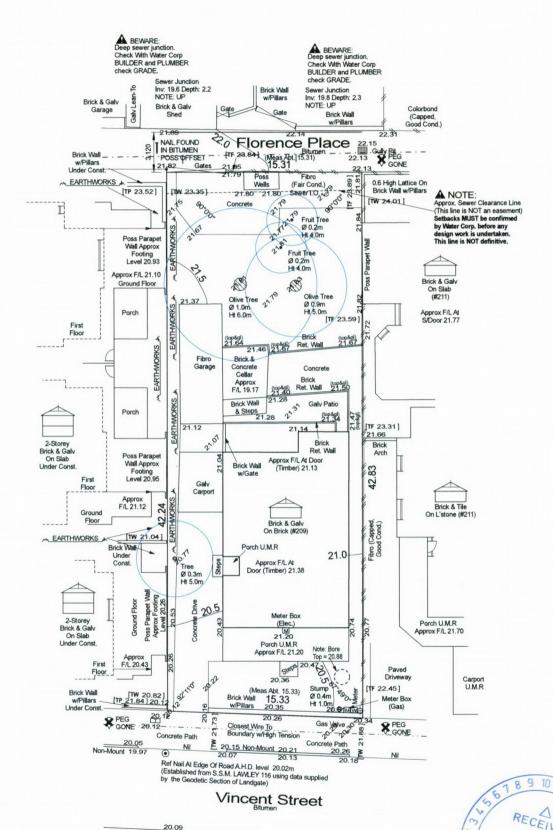

Traffic Island

LOT MISCLOSE 0.011 m

SOIL DESCRIPTION

Scale 1:200

▲ DISCLAIMER: HIGH TENSION POWER LINES, CHECK TITLE FOR EASEMENTS AND WESTERN POWER FOR SET-BACKS.



87-89 Guthrie Street, Osborne Park, Western Australia Telephone: (08) 9446 7361 Facsimile: (08) 9445 2998 Email: perth@cottage.com.au Website: www.cottage.com.au DATE:

19 Jul 17

421257

SCALE: DRAWN: 1:200 T.Currey **Builder: Averna Homes** 

CLIENT: KENWIN PROJECTS PTY LTD LOT 213 #209 Vincent Street, West Perth SHEET: 01 of 06 (REV H: Dated 14-03-18)

SEC Dome END Power Pole Phone Pits Water Conn. (D) [TP 10.00] Top Pillar/Post

[TW 10.00] Top Wall

[TR 10.00] Top Retaining [TF 10.00] Top Fence

D.Plan33158

OLD

AREA

CITY OF VINCENT **RECEIVED** 

15 Mar 2018

▲ DISCLAIMER:
Lot boundaries drawn on survey are based on landgate plan only. Survey does not include title search and as such may not show easements or other interests not shown on plan. Title should be checked to verify all lot details and for any easements or other interests which may affect building on the property.

### ▲ DISCLAIMER:

Survey does not include verification of cadastral boundaries. All features and levels shown are based on orientation to existing pegs and fences only which may not be on correct cadastral alignment. Any designs based or dependent on the location of existing features should have those features' location verified in relation to the true boundary.

▲ DISCLAIMER: Survey shows visible features only and will not show locations of underground pipes or conduits for internal or mains services. Verification of the location of all internal and mains services should be confirmed prior to finalisation of any design work.

### ▲ DISCLAIMER:


Cottage & Engineering surveys accept no responsibility for any physical on site changes to the parcel or portion of the parcel of land shown on this survey including any adjoining neighbours levels and features that have occurred after the date on this survey. All Sewer details plotted from information supplied by Water Corporation.

### ▲ DISCLAIMER:

Due to lack of survey marks/pegs, all building offset dimensions & features are approximate only and positioned from existing pegs/fences and walls which may not be on the correct alignment and are to be verified when repegged. Any design that involves additions to any structures shown or portion of structures remaining after any demolition has taken place requires boundaries to be repegged and exact offsets provided to your designer/architect before any plans are produced and before any work is started on site.





### Florence Place

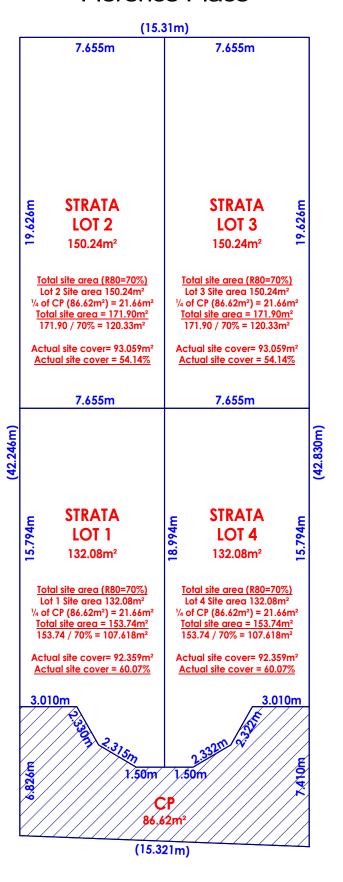


Vincent Street

# **PROPOSED STRATA PLAN**

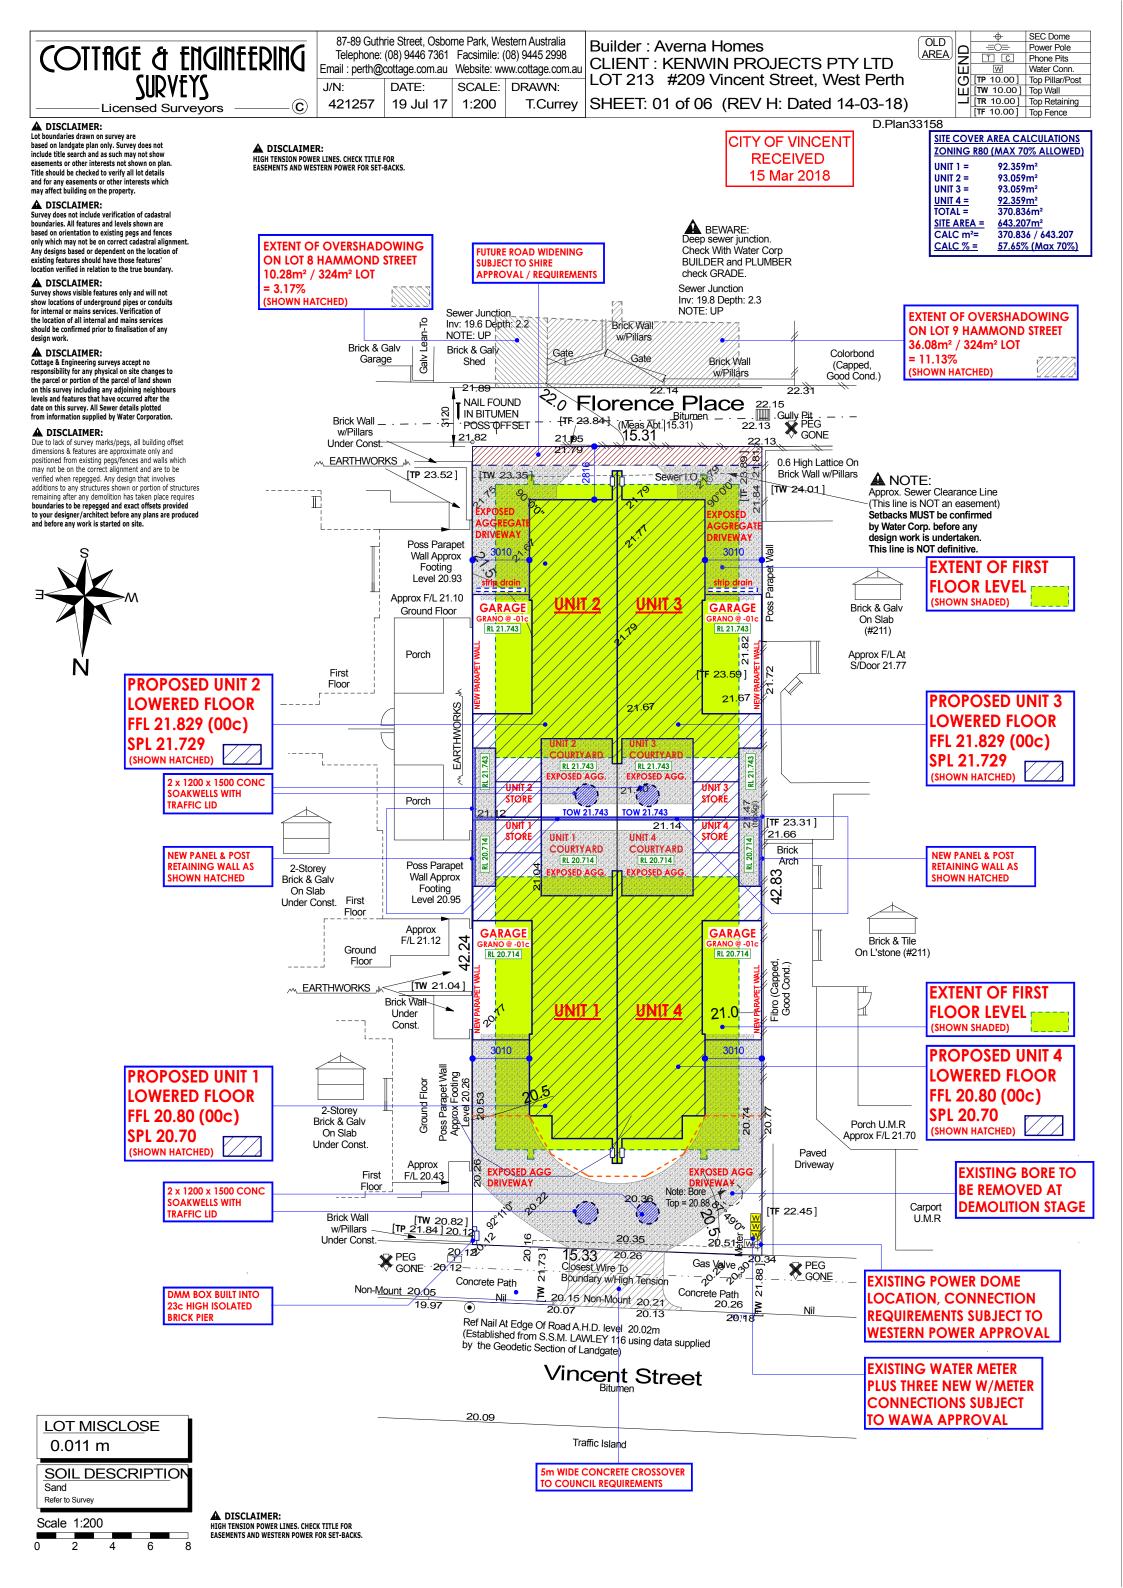

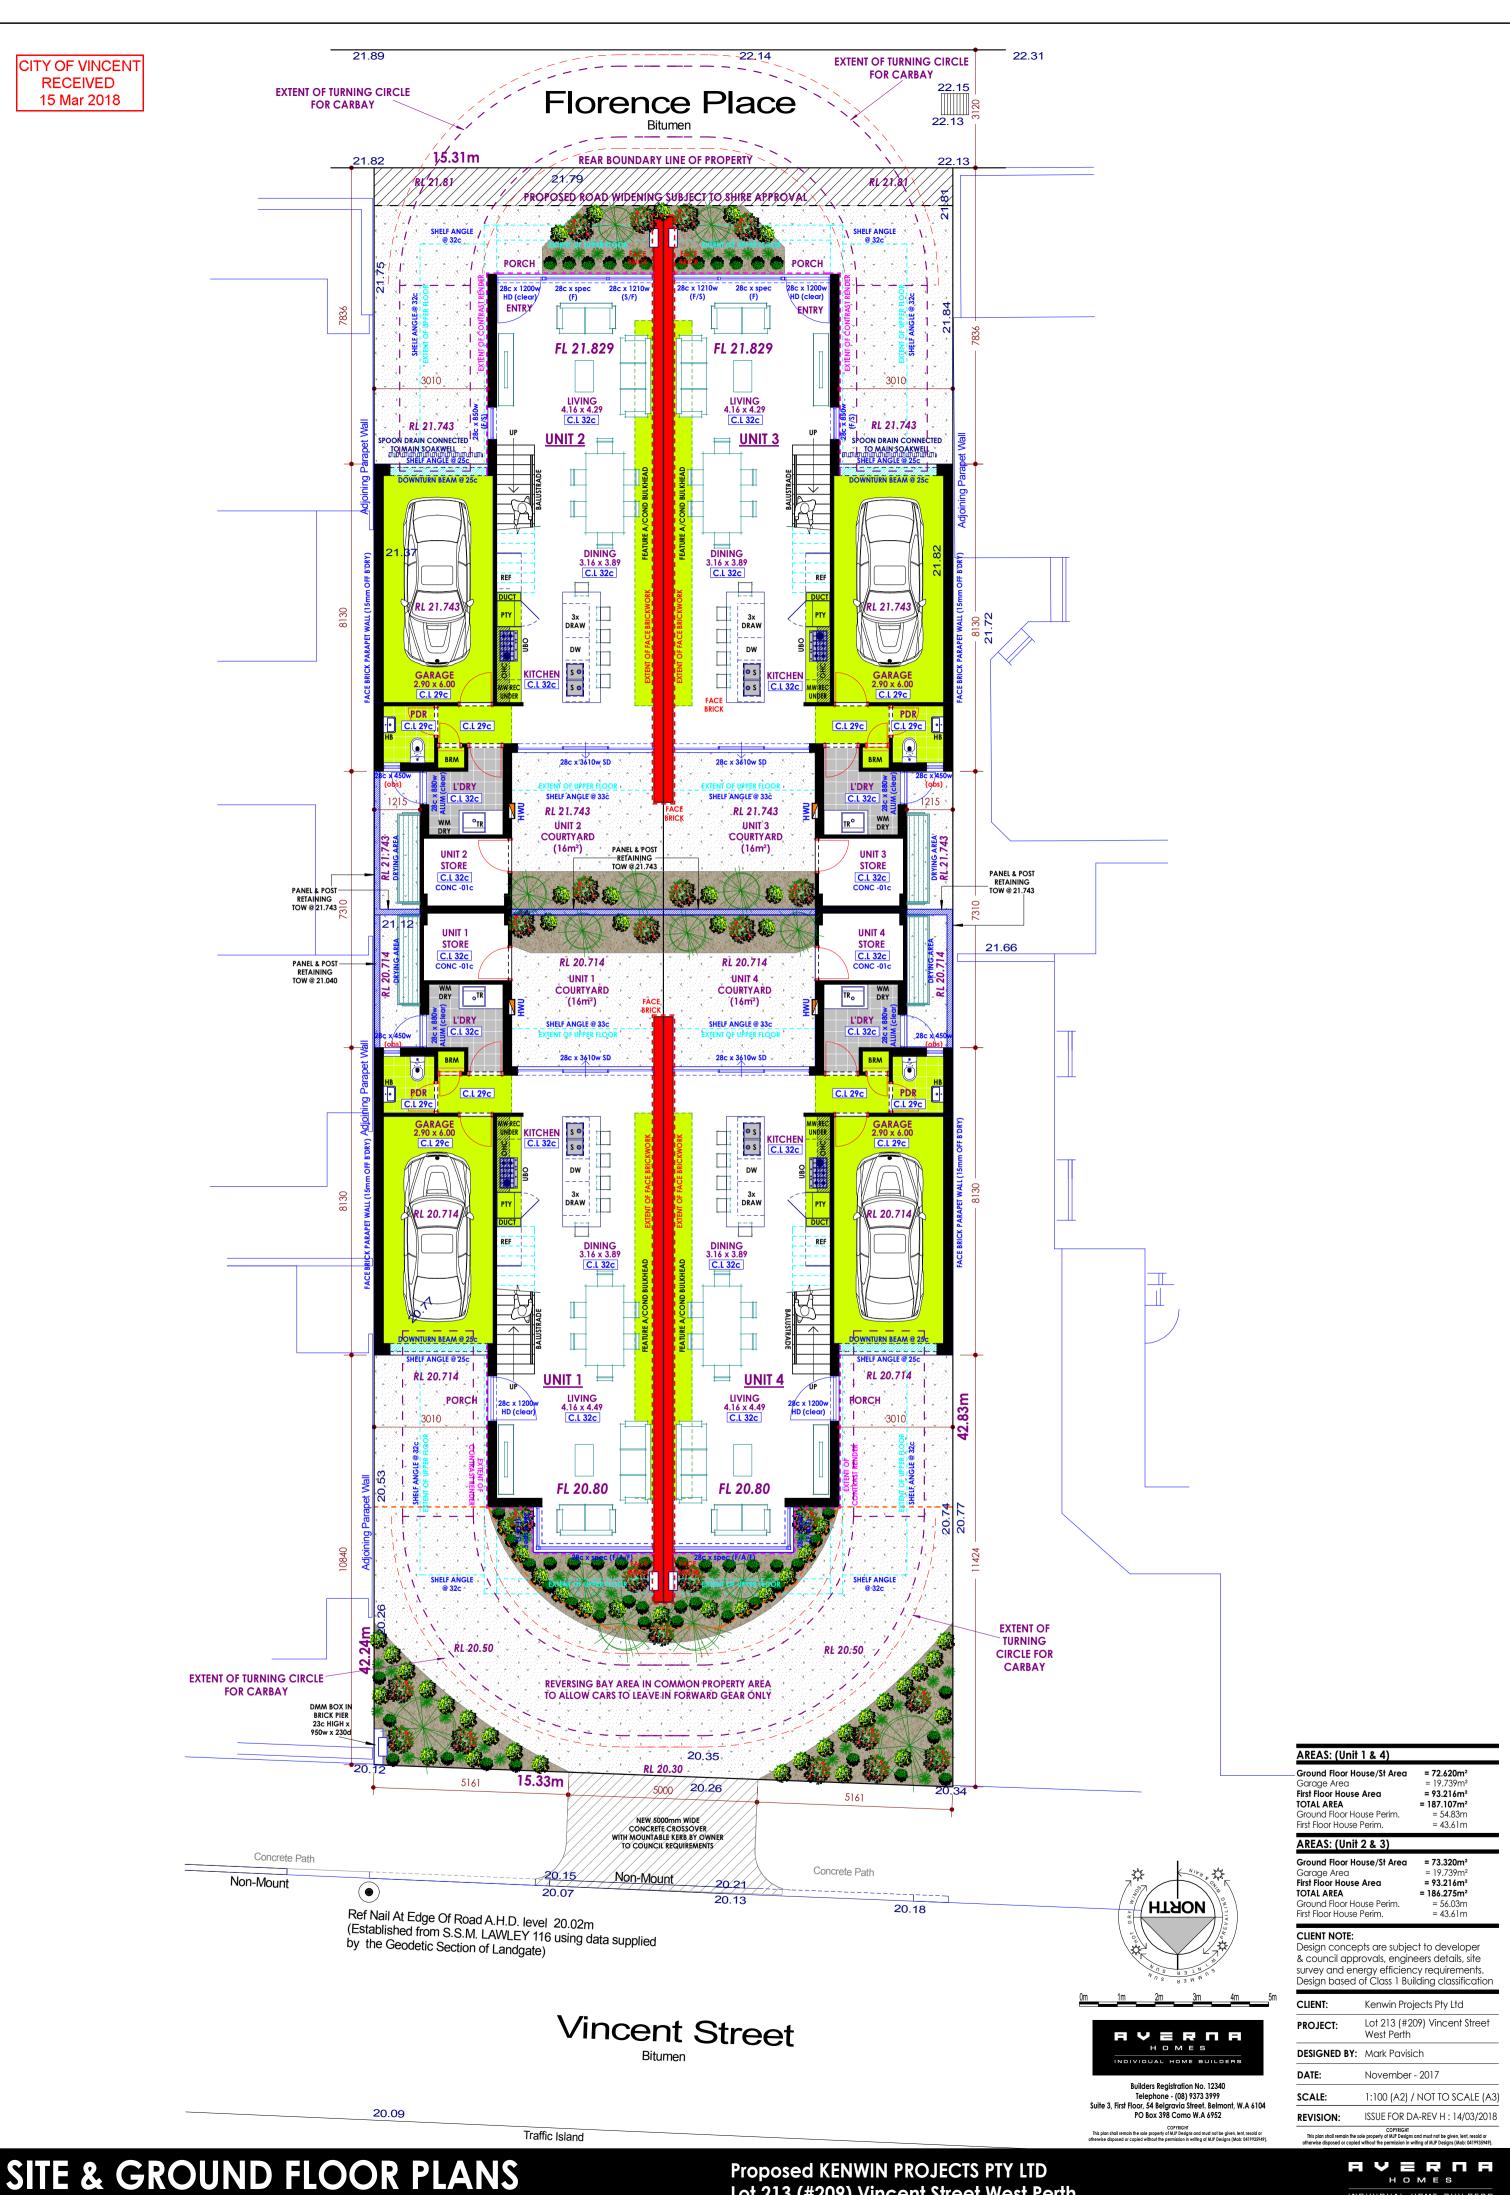

CITY OF VINCENT RECEIVED 15 Mar 2018

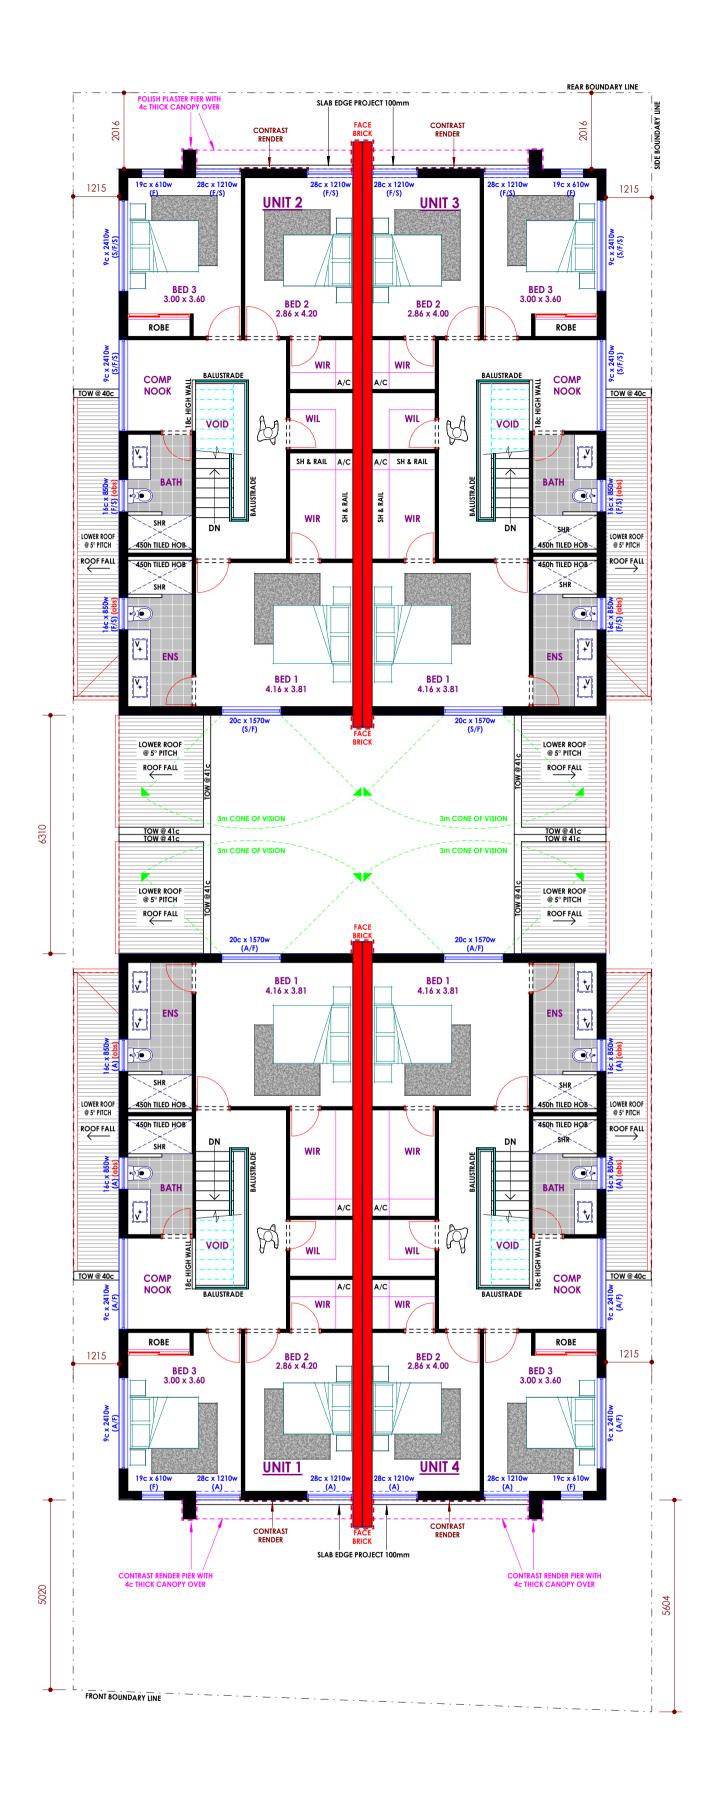





Builders Registration No. 12340 Telephone - (08) 9373 3999 Suite 3, First Floor, 54 Belgravia Street. Belmont, W.A 6104 PO Box 398 Como W.A 6952

AREAS: (Unit 1 & 4)	
Ground Floor House/\$1 Area Garage Area First Floor House Area TOTAL AREA Ground Floor House Perim. First Floor House Perim.	= 72.620m <sup>2</sup> = 19.739m <sup>2</sup> = 93.216m <sup>2</sup> = 187.107m <sup>2</sup> = 54.83m = 43.61m

ΔRFΔS: (Unit 2 & 3)		
First Floor House Perim.		
Ground Floor House Fellin.		
Ground Floor House Perim.		

Ground Floor House/St Area = 73.320m<sup>2</sup> Garage Area
First Floor House Area = 19.739m<sup>2</sup> = **93.216m**<sup>2</sup> TOTAL AREA
Ground Floor House Perim.
First Floor House Perim. = 186.275m<sup>2</sup> = 56.03m = 43.61m


# CLIENT NOTE:

Design concepts are subject to developer & council approvals, engineers details, site survey and energy efficiency requirements. Design based of Class 1 Building classification

PROJECT: Lot 213 (#209) Vincent Street West Perth  DESIGNED BY: Mark Pavisich	CLIENT:	Kenwin Projects Pty Ltd	
DESIGNED BY: Mark Pavisich	PROJECT:	Lot 213 (#209) Vincent Street West Perth	
	DESIGNED BY:	Mark Pavisich	

COPYRIGHT
This plan shall remain the sole property of MJP Designs and must not be given, lent, resold or otherwise disposed or copied without the permission in writing of MJP Designs (Mob: 0419935949).



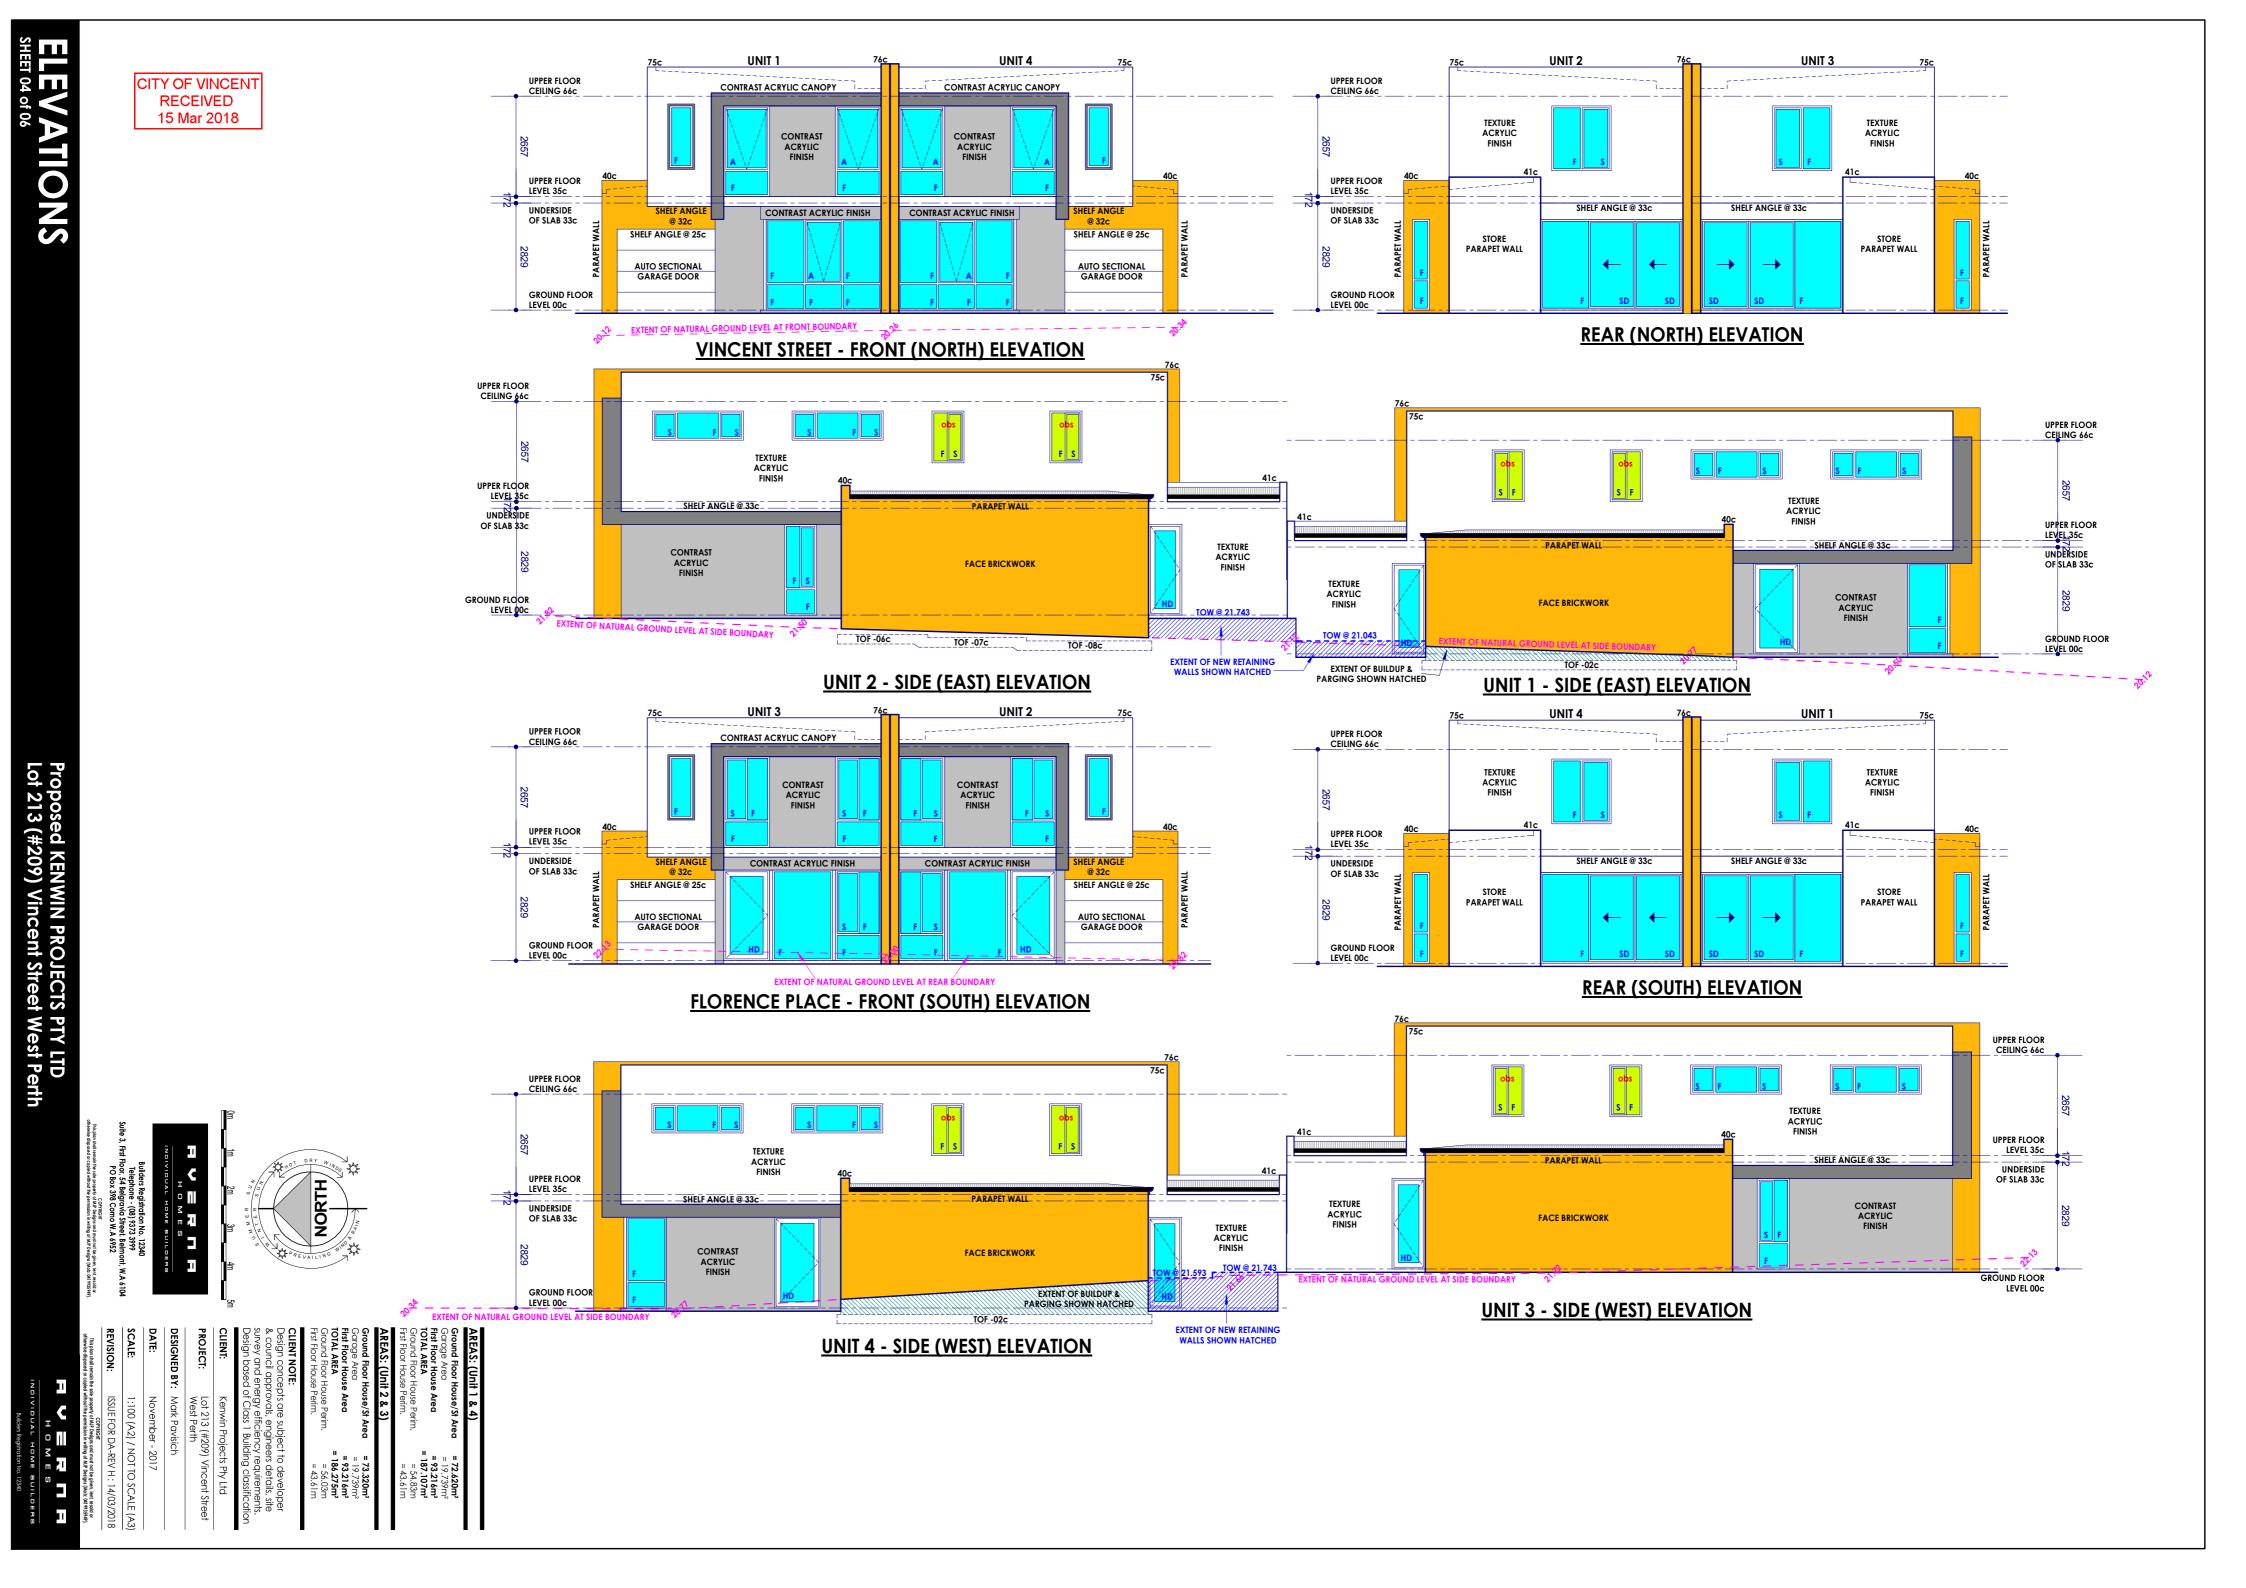





VINCENT STREET NORTH-EAST FRONT ELEVATION




VINCENT STREET NORTH-EAST SIDE ELEVATION



**VINCENT STREET NORTH-WEST FRONT ELEVATION** 



FLORENCE PLACE SOUTH-WEST REAR STREET ELEVATION

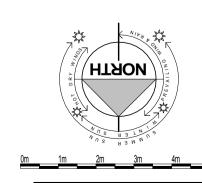



Builders Registration No. 12340 Telephone - (08) 9373 3999 Suite 3, First Floor, 54 Belgravia Street. Belmon PO Box 398 Como W.A 6952

AREAS: (Unit 1 & 4)			
Ground Floor House/St Area			
Garage Area			

= **74.152m²** = 19.739m² = 19.739m<sup>2</sup> = 93.216m<sup>2</sup> = 187.107m<sup>2</sup> = 55.63m = 43.61m First Floor House Area
TOTAL AREA
Ground Floor House Perim.
First Floor House Perim.

# AREAS: (Unit 2 & 3)

= 73.320m<sup>2</sup> = 19.739m<sup>2</sup> = 93.216m<sup>2</sup> Ground Floor House/St Area Garage Area
First Floor House Area TOTAL AREA
Ground Floor House Perim.
First Floor House Perim. = 186.275m<sup>2</sup> = 56.03m = 43.61m

CLIENT NOTE:
Design concepts are subject to developer & council approvals, engineers details, site survey and energy efficiency requirements.
Design based of Class 1 Building classification

CLIENT:	Kenwin Projects Pty Ltd
PROJECT:	Lot 213 (#209) Vincent Street West Perth
DESIGNED BY:	Mark Pavisich

DATE: November - 2017 1:100 (A2) / NOT TO SCALE (A3) ISSUE FOR DA-REV G: 01/03/2018